

# Sunnyside Office Development

Pre-qualification Questionnaire for the Procurement of Principal Building Contractor - Tender Addendum No.1

10 October 2019

PIC Handling & Classification: Confidential Document Ref: PICPROP013/09/2019



### **SECTION 1.0**

### **GENERAL INFORMATION**

PIC Handling & Classification: Confidential Document Ref: PICPROP013/09/2019



#### Dear Tenderer

# RE: Sunnyside Office Development – Pre-qualification Questionnaire for the Procurement of Principal Building Contractor -Tender Addendum No.1

In terms of the Tender, issued by Public Investment Corporation on the 30<sup>th</sup> September 2019, herewith please find enclosed the addendum for the subject project, which shall be included as part of the tender document submission when the tender closes.

Except to the extent modified by this Addendum, the original terms of the tender shall remain unchanged and binding on all the interested parties. The tenderer shall submit a copy of the addendum, including all tender deliverables specified in the original Tender Document.

The following changes are applicable to Tender Documents dated 30th September 2019

1.	Part B: Pre-Qualification Questionnaire Information and Instructions, Page 7	Replace with attached Part B: Questionnaire Information and Instructions, Page 7  Changes made:  The project is anticipated to start April 2020 and Practical Completion is anticipated to be April 2023.  Changed to:  The project is anticipated to start April 2020 and Final Completion is anticipated to be April 2023.
2.	Additional Information	Add attached Annexure C (Green Building Strategy)
3.	Additional Information (Drawings)	See attached additional Drawings for Information Only:  1. 16028 - A100 - AREA SCHEDULES - GBA 2. 16028 - A100 - AREA SCHEDULES - GBA 3. 16028-101-SDP - L01 BASEMENT LVL 05 4. 16028-106-SDP - L06 GROUND FLOOR LVL 5. 16028-110-SDP - L10 PARKADE LVL 04 6. 16028-111-SDP - L11 FACILITIES LVL 7. 16028-112-SDP - L12 PODIUM RECEPTION LVL 8. 16028-113-SDP - L13 OFFICE LVL 01 9. 16028-120-SDP - L20 OFFICE LVL 08 10. 16028-121-SDP - L21 OFFICE LVL 09 - T1 ROOF 11. 16028-122-SDP - L22 OFFICE LVL 10 - T3 ROOF 12. 16028-124-SDP - L24 ROOF 13. 16028-200-SDP - NORTHERN ELEVATION 14. 16028-300-SDP - SECTION BB

PIC Handling & Classification: Confidential Document Ref: PICPROP012/8/2019



Date: 10 October 201	9
Project:	Sunnyside Office Development
Subject:	Pre-qualification questionnaire for the procurement of Principa Building Contractor -Tender Addendum No.1
Dear Tenderer,	
I/We the undersigned	I hereby confirm that we have received addendum no 1.
	t of addendum no 1 by signing and returning this page to z.za no later than Wednesday the 30 <sup>th</sup> of October 2019.
Company Name	
Name & Surname	
Signature	
Designation	
Date	

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#### 1. PRE-QUALIFICATION INFORMATION AND INSTRUCTIONS

The purpose of the pre-qualification process is to invite you to pre-qualify for the proposed Sunnyside Office Development project in Sunnyside, Pretoria. The project consist of 51000m<sup>2</sup> super basement parking, 44000m<sup>2</sup> above ground parking, 7800 m<sup>2</sup> podium level and three office towers total area of 46500m<sup>2</sup>.

Potential contractors are required to undergo a pre-qualification process that is designed to provide PIC with information to assist in the selection of potential contractors to tender for the works. The pre-qualification questionnaire (PQQ) responses will be evaluated in accordance with PIC's governance procedures. PIC intends that those who have adequately demonstrated that they have sufficient financial, economic, technical capacity, experience and ability to execute the project, be included in the tender process. The information requested will assist PIC in assessing each Contractor's capabilities and the more accurate the answers the better PIC will be able to match the Contractor's capabilities and PIC's needs to deliver this project.

The project is anticipated to start April 2020 and Final Completion is anticipated to be April 2023.

To assist PIC in evaluating the extent the submittals meet the pre-qualification requirements, all are required to duly complete the PQQ to ensure equitable consideration of all Questionnaires.

Responses to the PQQ will be used to inform decisions thus by responding fully to this questionnaire the Contractor warrants that:

- Their responses to the questionnaire are true and accurate.
- If requested by PIC, the Contractor will provide further evidence and / or examples to support the responses given.
- They will advise PIC on any material changes that occur during the vetting process or thereafter.
- Where evidence is required to be submitted with a response, Contractor's must ensure the same question reference is noted at the header of the document.
- All information submitted will be considered confidential and will be treated accordingly.
- Completion of this questionnaire does not guarantee that PIC will shortlist a Contractor for the tender stage.



# Annexure C (Green Building Strategy)



# Sunnyside Labour Campus Development

### Green Star SA Office v1.1 Strategy

MANAGEMENT	Points Avail	Points Targeted	Responsibility	4 Star Strategy	
MAN01 Green Star SA Accredited Professional	2	2	Sustainable Building Consultant	GSSA AP on design team A principal participant in the design team is a Green Star SA Accredited Professional and has been engaged by the building owner to provide sustainability advice from the schematic design phase through to construction completion.	
MAN05 Building Users' Guide	1	1	Building Owner/Solid Green	Building users' guide A simple and easy to use Building Users Guide, which includes information relevant for the building users, occupants and tenant representatives, is to be developed and made available to the building owner.	
MAN06 Environmental Management	2	1	Environmental Consultant	1 EMP The contractor is to implement a comprehensive, project specific Environmental Management Plan (EMP) for the works in accordance with Section 3 of the New South Wales (Australia) Environmental Management System guidelines 2007/2009.	
		1* TBC		1 The contractor has valid ISO14001 Environmental Management System (EMS) accreditation prior to and throughout the project.	
MAN07 Waste Management	3	3	Contractor	70% waste reused or recycled The contractor is to implement a Waste Management Plan (WMP), retain waste records and issue quarterly reports to the building owner; and 70% of all demolition and construction waste is to be reused or recycled.	
Total		7 Targeted			
		1* TBC	•		
IEQ	Points Avail	Points Targeted		4 Star Strategy	
IEQ01 Ventilation Rates	2	1	Mechanical	1 Mechanical ventilation with 33% improvement For 95% of the UA, outside air is to be provided at a rate 33% greater than the requirements of SANS 10400-0:2011.	
		1* TBC	. Engineer	2 Mechanical ventilation with 66% improvement For 95% of the UA, outside air is to be provided at a rate 66% greater than the requirements of SANS 10400-0:2011.	
IEQ04 Daylight	3	2	Architect	2 60% UA with adequate daylight 60% of UA is to have a measured Daylight Factor (DF) of not less than 2.0%, at desk-height level (720mm AFFL) under a uniform design sky. OR 60% of UA is to have a Daylight Illuminance (DI) of at least 250 Lux. OR 60% of UA is to have a Daylight Illuminance (DI) of at least 300 lux, based on an annual dynamic simulation model, for 50% of the standard occupied hours (Daylight Autonomy (DA) incremental method).	
IEQ05 Daylight Glare Control	1	1	Architect	Blinds - Blinds are to be fitted on all glazing and atria as a base building provision and meet the following criteria: Eliminate 95% of all direct sun penetration; and Have a visual light transmittance (VLT) of <10%.; and Can be controlled by all effected occupants within each floor or area	
IEQ08 External Views	2	1	Architect	1 60% UA with sight outdoors and into atria 60% of the office UA to have a direct line of sight to the outdoors or into an adequately sized and day-lit atrium.	
IEQ09 Thermal Comfort	2	1	Mechanical	1 Mechanical ventilation with PMV -1 to +1 The Predicted Mean Vote (PMV) levels, calculated in accordance with ISO7730 using standard clothing and metabolic rate values, are to be between 1 and +1, inclusive, for at least 98% of occupied hours during the year.	
		1* TBC Engineer/ GSSAAP		1 Mechanical ventilation with PMV -0,5 to 0,5 The Predicted Mean Vote (PMV) levels, calculated in accordance with ISO7730 using standard clothing and metabolic rate values, are to be between -0,5 and 0,5, inclusive, for at least 98% of occupied hours during the year.	



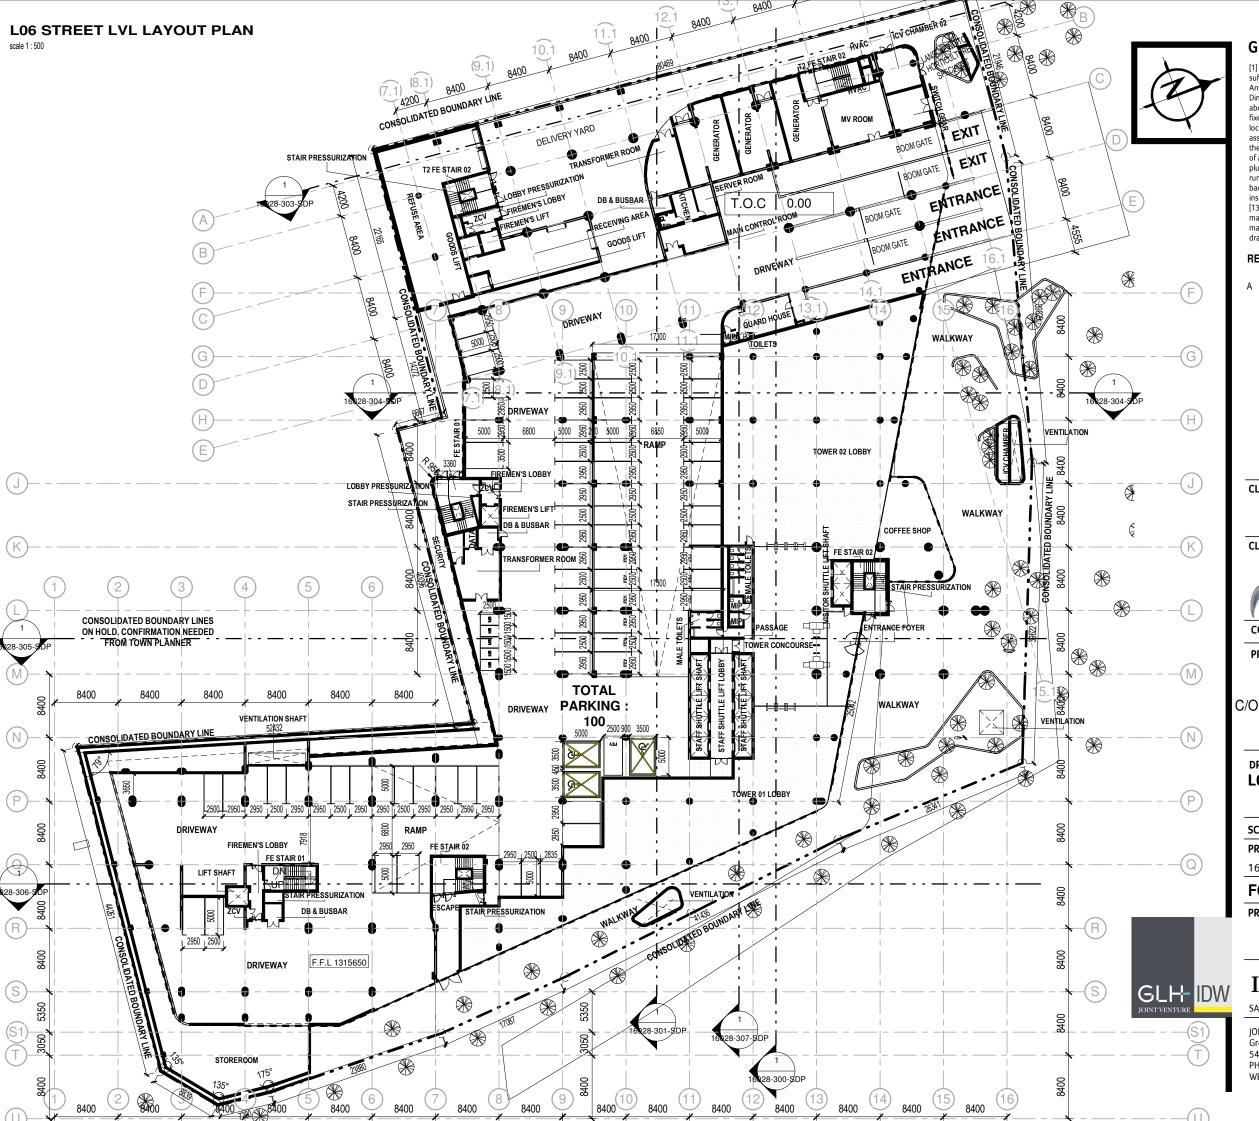
IEQ11 Hazardous Materials	1	NA	Contractor	NA No Existing structures on site For new developments where no buildings or structures were present at the time of purchase, this credit is 'Not Applicable' OR where demolition occurred prior to Oct 2010, this credit is 'Not Applicable'	
IEQ13 Low VOC Paints	1	1	Architect	1 Low VOC Paints At least 95% of all painted surfaces are to meet the TVOC Content Limits outlined in Table IEQ13.1 of the Office v1.1 Technical Manual.	
IEQ13 Adhesives & Sealants	1	1	Architect	Adhesives & Sealants At least 95% of all adhesives and sealants are to meet the TVOC Content Limits outlined in Table IEQ13.2 of the Office v1.1 Technical Manual.	
IEQ13 Low VOC Carpets or Flooring	1	1	Architect	Low VOC Carpets or Flooring All carpets or Flooring meet the TVOC emissions limits outlined in Table IEQ13.3 of the Office v1.1 Technical Manual.	
IEQ17 Environmental Tobacco Smoke (ETS) Avoidance	1	1	Building Owner	Environmental tobacco smoke avoidance	
Total		10 targeted			
		2* TBC			
ENERGY	Points Avail	Points Targeted		4 Star Strategy	
ENE00 Conditional Requirement	0	MET	Sustainable Building Consultant	met Refer to ENE-01 Refer to ENE-01	
ENE01 Greenhouse Gas Emissions	20	8	Sustainable Building Consultant	8	
ENE02 Electrical Energy Sub- metering	2	2	Electrical Engineer	2 Sub-metering 100kVA, Lighting & Small Power Sub-metering is to be provided for substantive energy uses within the building (i.e. all energy uses of 100kVA or greater); There is an effective mechanism for monitoring energy consumption data from all energy submeters; AND Submetering is to be provided for lighting and separately for power for each floor for 95% of the total UA	
ENE03 Lighting Power Density	4	4	Electrical Engineer	4 Lighting power density of 1.5W/m2 per 100 Lux The lighting power density for 95% of the UA is to be 1.5W/m2 per 100 Lux at 720mm above FFL with the default maintenance factor of 0.8.	
ENE04 Lighting Zones	2	1	Electrical Engineer	1 Individually switched zones All individual or enclosed spaces are to be individually switched (manual or occupancy sensors); The size of individually switched lighting zones is not to exceed 100m≤ for 95% of the UA; and manual switching is to be clearly labelled and easily accessible by building occupants.	
Total		15 Targeted			
TRANSPORT	Points Avail	Points Targeted		4 Star Strategy	
TRA02 Fuel- Efficient Transport	2	2	Architect	2 Fuel-efficient vehicles A minimum of 5% of all parking spaces are dedicated solely for use by hybrid and other alternative fuel vehicles. All qualifying spaces must be located in preferred parking locations and be designed and labelled for the intended vehicle types; AND A minimum of 5% or 5 parking spaces (whichever is greater) are designed and labelled for mopeds, scooters and/or motorbikes, and all of these spaces must be located in preferred parking locations.	
TRA03 Cyclist Facilities	3	2 *	Architect	2 Storage for 3% building staff - Visitor parking Safe, convenient cycling routes are provided between the office development and the adjacent street network; AND secure bicycle storage for 3% of building staff is provided (based on one person per 15m≤ of UA); AND accessible showers are provided (based on one per 10 bicycle spaces provided or part thereof); AND changing facilities adjacent to showers are provided; AND one secure locker per bicycle space in the changing facilities is provided;	
				AND visitor bicycle parking is provided and meets the following criteria: One space per 750m≤ UA or part thereof; and provided in an accessible location, signposted and close to, or adjacent to, a major public entrance to the building.	



TRA04 Commuting Mass Transport	5	1	Traffic Engineer/Solid Green	Calculator = 10 The completed Green Star SA Office v1 Commuting Mass     Transport Calculator indicates a minimum of 10 points are achieved, therefore the number of points for the credit is 1	
TRA05 Local Connectivity	2	1	Architect / Solid Green	1 Local connectivity Safe, well lit, dedicated pedestrian facilities are to be provided between the office development and the adjacent street network, conforming to SANS 10246; and Four of the following are to be located within 400 m of a public entrance to the building:- Bank / ATM- Convenience Grocery / Supermarket- Day-care / School- Cleaner / Laundry- Medical / Dental Offices-Pharmacy- Post Office- Restaurant / Canteen / Cafeteria- Fitness Centre / Gym-Library	
Total		6 Targeted			
WATER	Points Avail	Points Targeted		4 Star Strategy	
WAT01 Occupant Amenity Water	5	3	Wet Services Engineer	3 3 points The potable water calculator result is 3 points. — Use of low flow fittings (taps , WC's, urinals and showerheads)	
WAT02 Water Meters	2	2	Wet Services Engineer	2 Water meters Water meters are to be installed for all major water uses in the project; and effective monitoring system to be in place	
WAT03 Landscape Irrigation - Point 1&2	2	1	Landscape Architect	1 50% irrigation reduction Potable water consumption for landscape irrigation is to be reduced by 50%; 90% OR installation of a xeriscape garden	
WAT04 Heat Rejection Water	4	4	Mechanical Engineer	4 No water consumed [Natural or Mechanically Assisted Ventilation] No water consuming heat rejection systems are to be provided and the building is to be naturally or mechanically assisted ventilated	
Total		10 Targeted			
MATERIALS	Points Avail	Points Targeted		4 Star Strategy	
MAT01 Recycling Waste Storage	2	2	Architect	2 Adequately sized Storage facility provided A dedicated storage area is to be provided for the separation and collection of office consumables with good access for all building occupants and for collection by recycling companies; The storage area shall be adequately sized, in accordance with Table MAT-1.1 and comply with at least one of the following: - within 20m of the base of the lift core/principal vertical circulation serving all floor - within 20m of the exit used for recycling pickup - within 3m of the shortest route connecting the lift cores serving all floors and the exit used for recycling pickup	
MAT02 Building Reuse	5	NA	Architect	NA No existing structures on site at time of purchase or GFA original building 20% less than new building. The site contained no buildings at the time of purchase, OR. The total GFA of the original building(s) is less than 20% of the GFA of the new building that replaces it, therefore this credit is 'Not Applicable'	
MAT04 Shell and Core or Integrated Fit-out	1	1	Architect	Integrated fit-out 90% of the UA of the project is to be delivered as integrated fitout.	
MAT05 Concrete	3	1	Structural Engineer	30 % Average reduction of Portland cement     An absolute reduction of 30 % of OPC is achieved as an average across all concrete mixes.	
MAT06 Steel	3	3	Structural Engineer	3 All Steel 90% of all steel ( total of structural steel, reinforcing steel and steel products ) by mass, in the project either is to be reused or as postconsumer recycled content of greater than 60%	
Total		7 Targeted			
LAND USE & ECOLOGY	Points Avail	Points Targeted		4 Star Strategy	
ECO00 Conditional Requirement	0	MET	Ecologist	met Developmental Footprint not within 100m of a watercourse The Eco- Conditional Requirement is met where the project development footprint: > Is not	



				located on prime agricultural land > ls not located on vegetation of high ecological	
				value or within a 100 meter buffer of vegetation of high ecological value > ls not located on land with confirmed presence or high probability of threatened red-listed species, or within a defined buffer relevant to the specific threatened red-listed species or habitat found > ls not located within the 100 year floodplain AND > ls not located within 100 meters of a watercourse.	
ECO02 Reuse of Land	2	2	Architect	2 Reuse of Land within the urban edge The site is within the approved urban edge AND One of the following: - The project is to be refurbishment or a building extension. OR - If at the time of site purchase, the existing developing footprint (previously developed land) represents no less than 75% of the site area.	
Total		2 Targeted			
EMISSIONS	Points Avail	Points Targeted		4 Star Strategy	
EMI01 Refrigerant / Gaseous ODP	1	1	Mechanical /Wet Services Engineer	HVAC refrigerants and Gaseous Fire suppression systems have ODP of     HVAC refrigerants (including any heat pumps for DHW production) and gaseous     fire suppressions system(s) have an Ozone Depleting Potential (ODP) of zero.	
EMI04 Insulant ODP	1	1	Architect/ Mechanical / Wet Services Engineer	Thermal insulants with zero ODP No ozone depleting substances are associated with either the manufacture or the composition of all thermal insulants in the project.	
EMI06 Discharge to Sewer	4	2	Wet Services Engineer / Solid Green	2 50% sewage reduction The building outflows to the sewerage system due to building occupants' usage are to be reduced by 50% against an average practice benchmark	
EMI06 Discharge to Sewer - Blackwater	1	na	Wet Services Engineer	na ROUTE NA No Blackwater treatment system installed	
EMI08 Legionella	1	1	Mechanical Engineer	No evaporative cooling towers or systems	
Total		5 Targeted			
INNOVATION	Points Avail	Points Targeted		4 Star Strategy	
INN02 Exceeding Green Star SA	10 0		Sustainable	1 Local Connectivity – To be determined by the entrances of all three buildings	
Benchmarks		1* TBC	Building Consultant		
INN03 Environmental Design Initiatives	10	3		2 Financial Transparency  Explanation: The project submits a full set of their project financials in accordance with the relevant template provided for the relevant rating tool for new build- used for GBCSA research not public information  1 Multiple Ratings_Building Owner to be confirm going for Both Ratings	
			Quantity Surveyor		
		3* TBC	Project Team	2 Online AP course – To be confirmed , project to confirm.  Explanation:  5 Professional Team members and 4 Contractors have completed New Build Course	
		<b>3*</b> TBC		Explanation: 5 Professional Team members and 4 Contractors have completed New Build	
Total		3*TBC		Explanation: 5 Professional Team members and 4 Contractors have completed New Build Course  1 Stairs – To be confirmed Explanation: The project awarded an innovation point for providing prominent stairs at the entrance of the building to encourage building occupants to take the stairs and	
Total				Explanation: 5 Professional Team members and 4 Contractors have completed New Build Course  1 Stairs – To be confirmed Explanation: The project awarded an innovation point for providing prominent stairs at the entrance of the building to encourage building occupants to take the stairs and	
		3 Targeted		Explanation: 5 Professional Team members and 4 Contractors have completed New Build Course  1 Stairs – To be confirmed Explanation: The project awarded an innovation point for providing prominent stairs at the entrance of the building to encourage building occupants to take the stairs and	
Total  TOTAL POINTS		3 Targeted		Explanation: 5 Professional Team members and 4 Contractors have completed New Build Course  1 Stairs – To be confirmed Explanation: The project awarded an innovation point for providing prominent stairs at the entrance of the building to encourage building occupants to take the stairs and promote the well-being of occupants.	



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#### REV ISSUE DATE DESCRIPTION

2019-09-26 ISSUED FOR TENDER

#### CLIENT/ -REPRESENTATIVE SIGNATURE

PUBLIC INVESTMENT

PUBLIC INVESTMENT

**CORPORATION** 

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PROJECT NAME & DESCRIPTION

#### SUNNYSIDE OFFICE DEVELOPMENT

C/O PARK STR & STEVE BIKO STR, SUNNYSIDE, PRETORIA, TSHWANE

# DRAWING DESCRIPTION LO6 GROUND FLOOR LVL

SCALE 1:5	00	PRINT SIZE	А3	DRAWN BY	B.K
PROJECT NUM	BER	DRAWING NU	MBER	CHECKED BY	M.L
16028		16028-106-	SDP	REVISION	Α

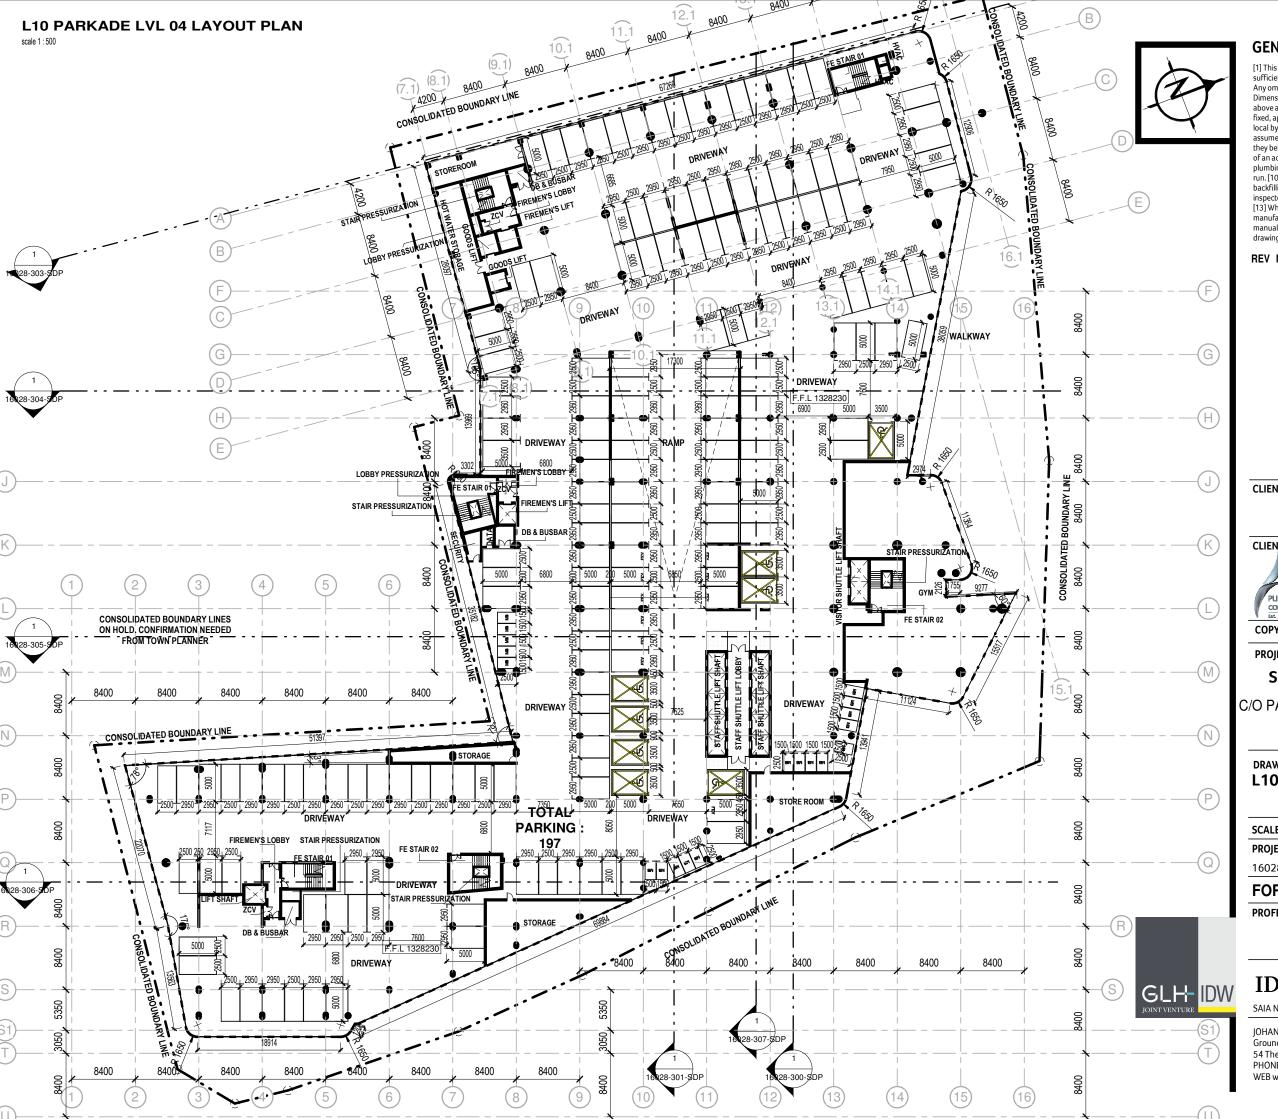
#### FOR INFORMATION

PROFESSIONAL'S SIGNATURE & REGISTRATION NO.

### IDW GLH JOINT VENTURE

SAIA No. PG 0446 & PI 4669

JOHANNESBURG Ground Floor, La Roche, 54 The Valley rd., Parktown PHONE +27 (0) 11 486 2770 WEB www.glh.co.za



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DRAWING DESCRIPTION
L10 PARKADE LVL 04

SCALE 1:500	PRINT SIZE A3		DRAWN BY	M Louw
PROJECT NUMBER	DRAWING NUMBER		CHECKED BY	M.L
16028	16028-110-9	SDP	REVISION	

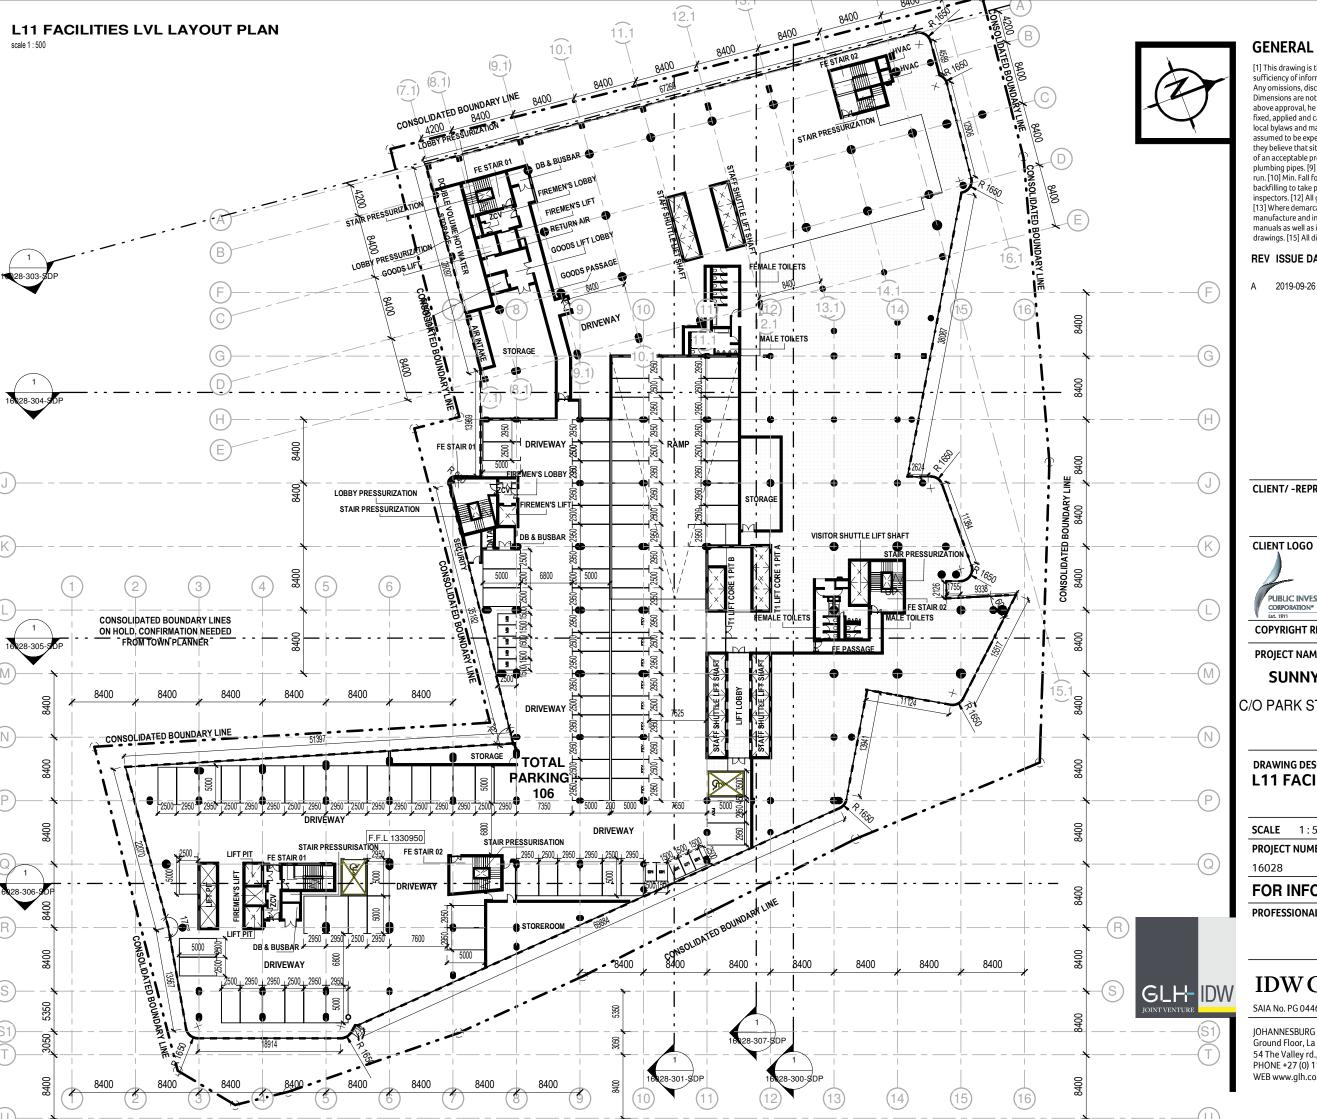
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#### SUNNYSIDE OFFICE DEVELOPMENT

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#### DRAWING DESCRIPTION **L11 FACILITIES LVL**

CALE	1:500	PRINT SIZE	А3	DRAWN BY	B.K
PROJECT	NUMBER	DRAWING NU	IMBER	CHECKED BY	M.L
16028		16028-111-	-SDP	REVISION	Α

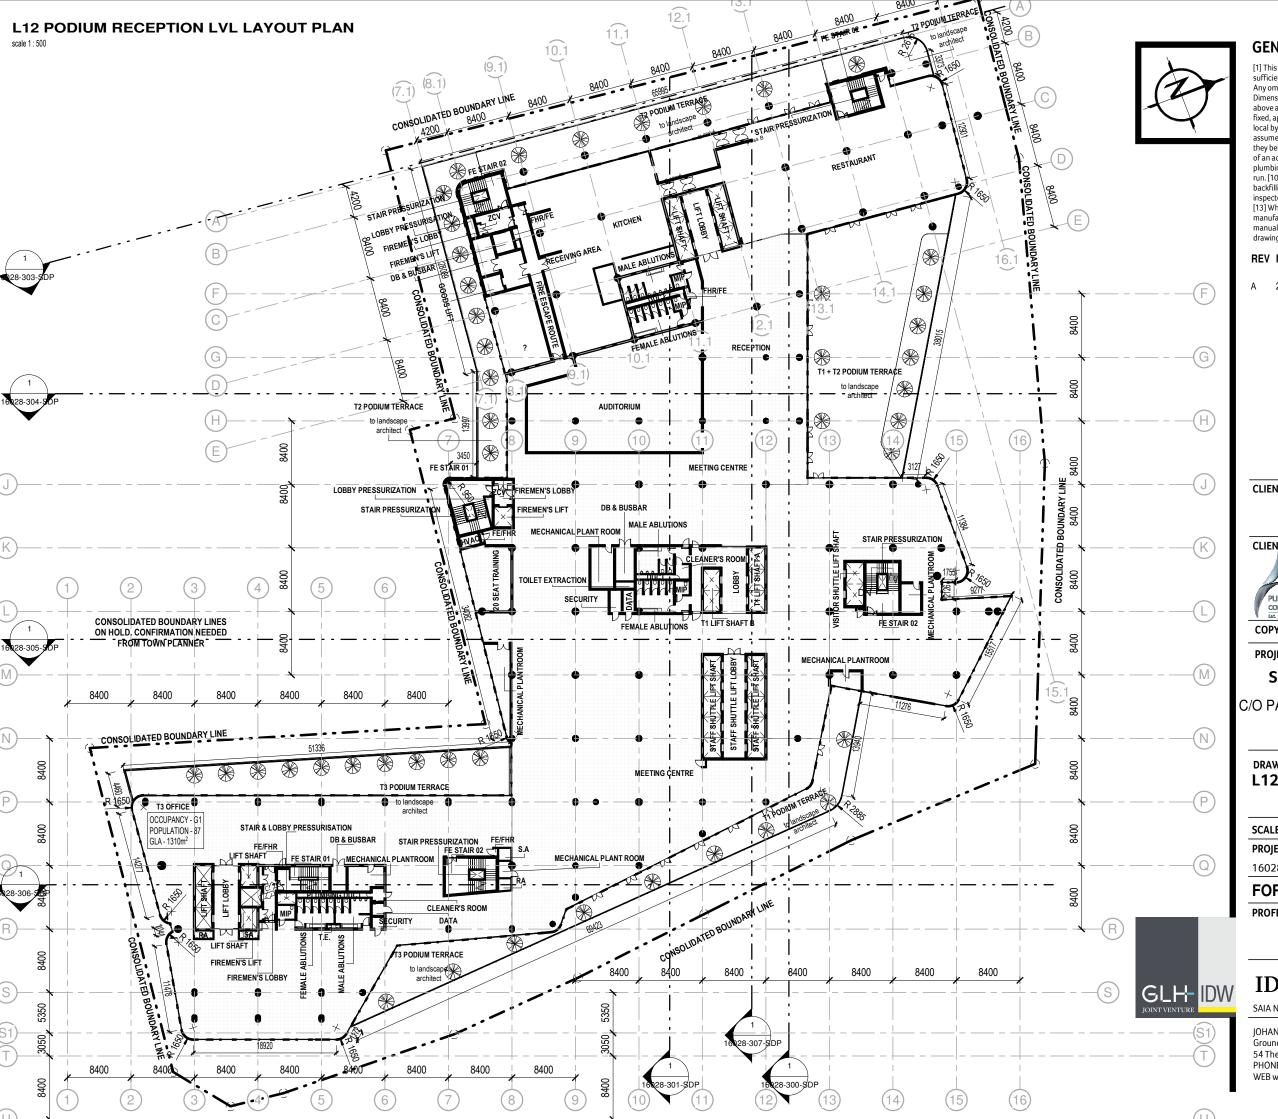
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# DRAWING DESCRIPTION L12 PODIUM RECEPTION LVL

<b>SCALE</b> 1:500	PRINT SIZE A3	DRAWN BY	B.K
PROJECT NUMBER	DRAWING NUMBER	CHECKED BY	M.L
16028	16028-112-SDP	REVISION	Α

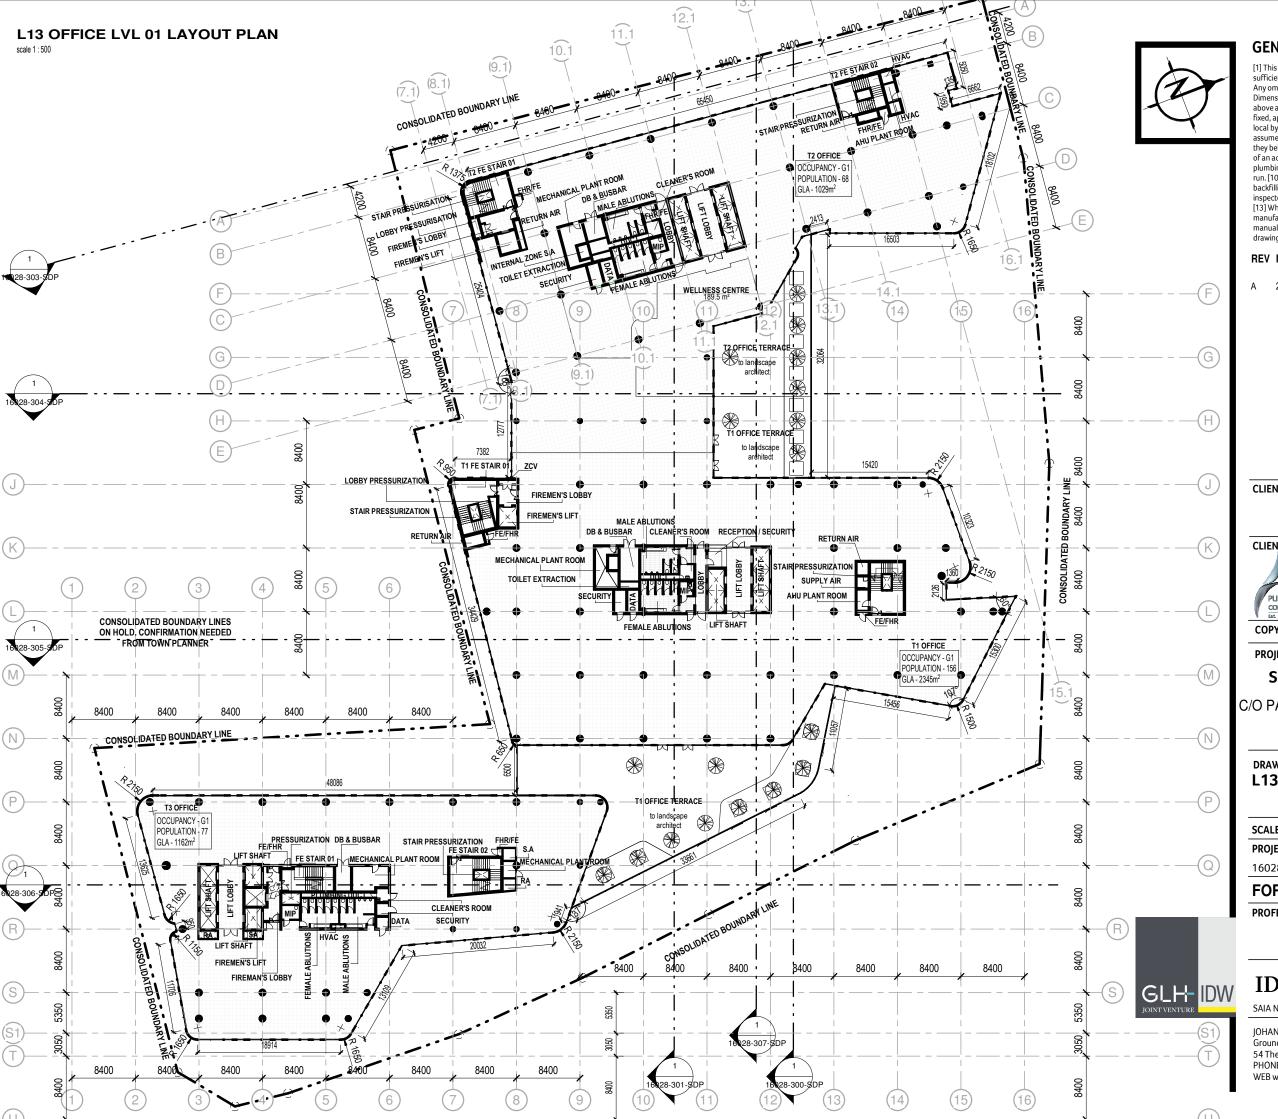
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#### REV ISSUE DATE DESCRIPTION

2019-09-26 ISSUED FOR TENDER

#### **CLIENT/-REPRESENTATIVE SIGNATURE**

PUBLIC INVESTMENT

DETAILS

PUBLIC INVESTMENT CORPORATION

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PROJECT NAME & DESCRIPTION

#### SUNNYSIDE OFFICE DEVELOPMENT

C/O PARK STR & STEVE BIKO STR, SUNNYSIDE, PRETORIA, TSHWANE

# DRAWING DESCRIPTION L13 OFFICE LVL 01

SCALE	1:500	PRINT SIZE	А3	DRAWN BY	B.K
PROJECT	NUMBER	DRAWING NU	MBER	CHECKED BY	Checker
16028		16028-113-	-SDP	REVISION	А

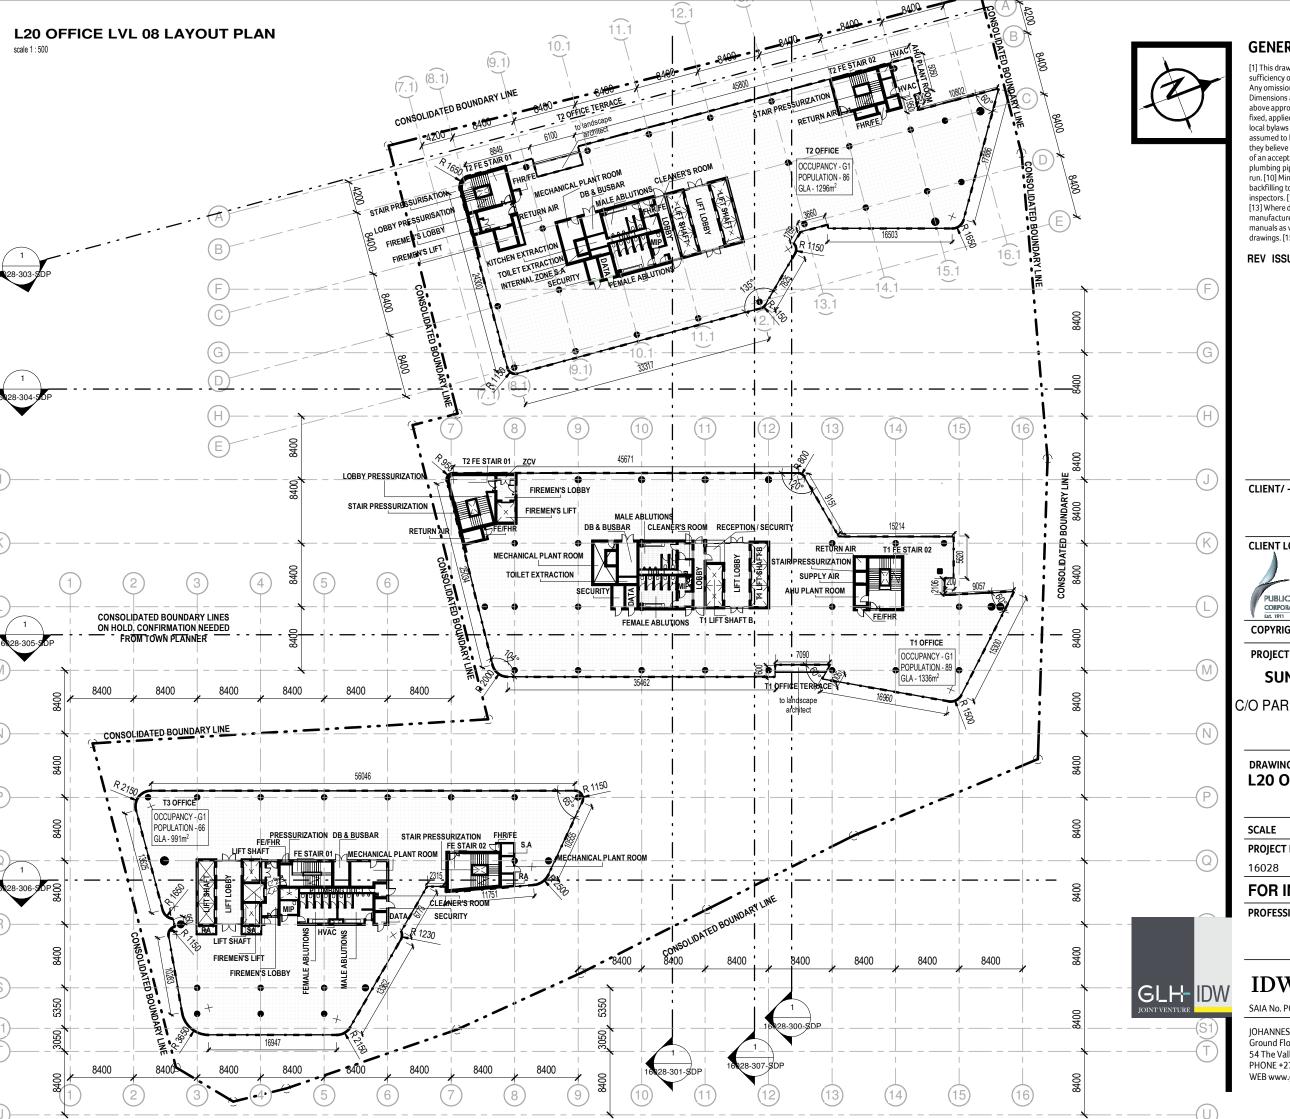
#### FOR INFORMATION

PROFESSIONAL'S SIGNATURE & REGISTRATION NO.

### IDW GLH JOINT VENTURE

SAIA No. PG 0446 & PI 4669

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**REV ISSUE DATE DESCRIPTION** 

CLIENT/ -REPRESENTATIVE SIGNATURE

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PROJECT NAME & DESCRIPTION

#### SUNNYSIDE OFFICE DEVELOPMENT

**DETAILS** 

C/O PARK STR & STEVE BIKO STR, SUNNYSIDE, PRETORIA, TSHWANE

DRAWING DESCRIPTION **L20 OFFICE LVL 08** 

<b>SCALE</b> 1:500	PRINT SIZE A3	DRAWN BY	M Louw
PROJECT NUMBER	DRAWING NUMBER	CHECKED BY	Checker
16028	16028-120-SDP	REVISION	

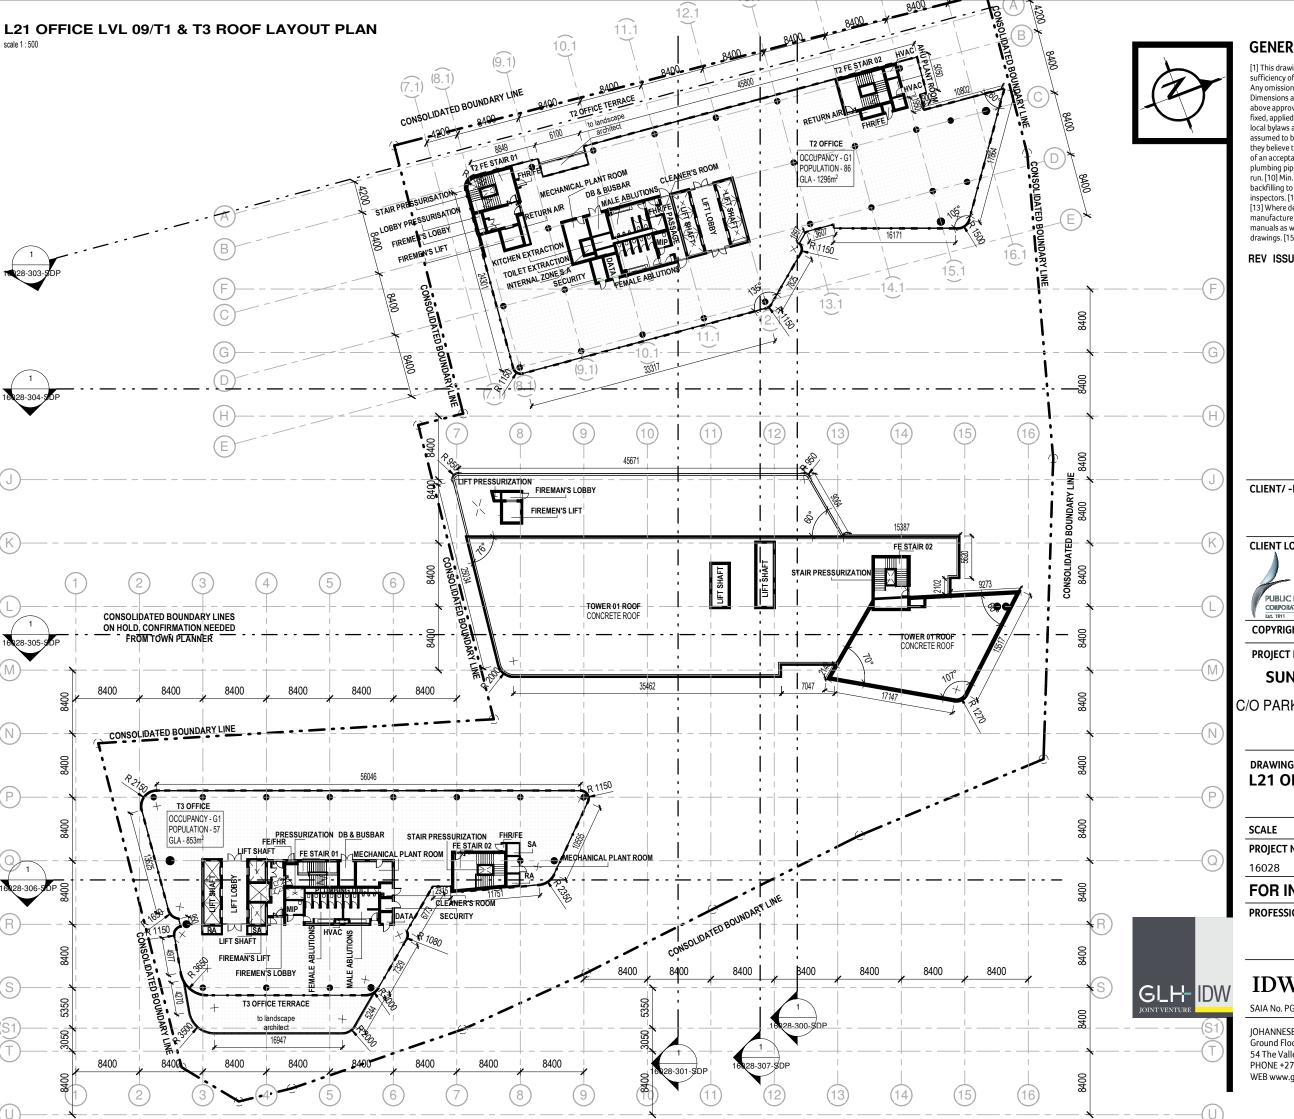
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PROFESSIONAL'S SIGNATURE & REGISTRATION NO.

### IDW GLH JOINT VENTURE

SAIA No. PG 0446 & PI 4669

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#### SUNNYSIDE OFFICE DEVELOPMENT

C/O PARK STR & STEVE BIKO STR, SUNNYSIDE, PRETORIA, TSHWANE

**DETAILS** 

DRAWING DESCRIPTION L21 OFFICE LVL 09 / T1 ROOF

<b>SCALE</b> 1:500	PRINT SIZE A3	DRAWN BY	M Louw
PROJECT NUMBER	DRAWING NUMBER	CHECKED BY	Checker
16028	16028-121-SDP	REVISION	

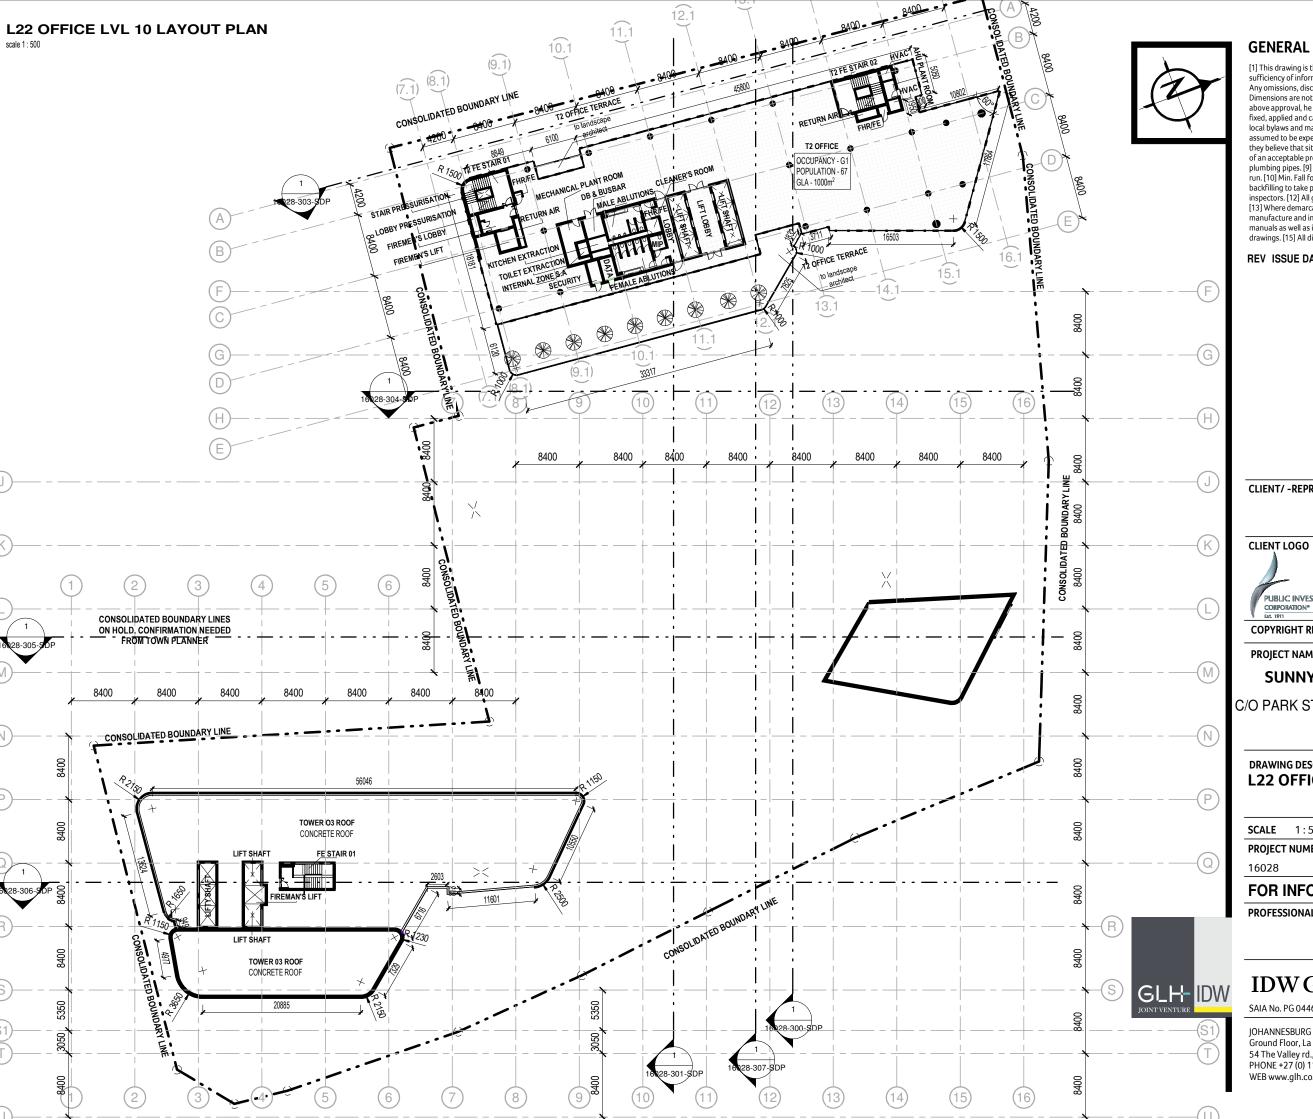
#### **FOR INFORMATION**

PROFESSIONAL'S SIGNATURE & REGISTRATION NO.

### IDW GLH JOINT VENTURE

SAIA No. PG 0446 & PI 4669

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**REV ISSUE DATE DESCRIPTION** 

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PROJECT NAME & DESCRIPTION

#### SUNNYSIDE OFFICE DEVELOPMENT

C/O PARK STR & STEVE BIKO STR, SUNNYSIDE, PRETORIA, TSHWANE

DRAWING DESCRIPTION L22 OFFICE LVL 10 / T3 ROOF

<b>SCALE</b> 1:500	PRINT SIZE A3	DRAWN BY	M Louw
PROJECT NUMBER	DRAWING NUMBER	CHECKED BY	Checker
16028	16028-122-SDP	REVISION	

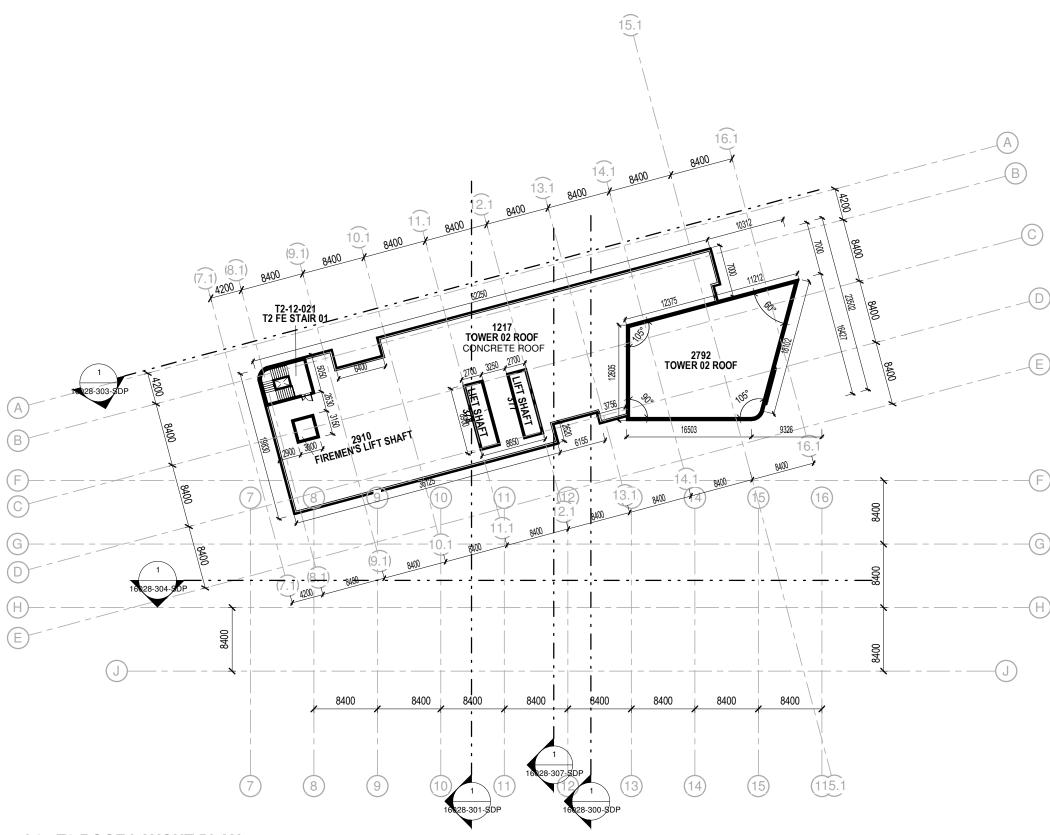
#### **FOR INFORMATION**

PROFESSIONAL'S SIGNATURE & REGISTRATION NO.

### IDW GLH JOINT VENTURE

SAIA No. PG 0446 & PI 4669

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**L24 T2 ROOF LAYOUT PLAN** 

scale 1 : 500



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REV ISSUE DATE DRAWING REVISION DESCRIPTION

#### DRAWING LEGEND / KEY SITE PLAN

CLIENT LOGO DETAILS
PUBLIC

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C/O PARK STR & STEVE BIKO STR, SUNNYSIDE, PRETORIA, TSHWANE

DRAWING DESCRIPTION L24 ROOF

SCALE 1:500	PRINT SIZE A3	DRAWN BM Louw
PROJECT NUMBER	DRAWING NUMBER	REVISION 1st. DATE
16028	16028-124-SDP	05/10/19

FOR INFORMATION



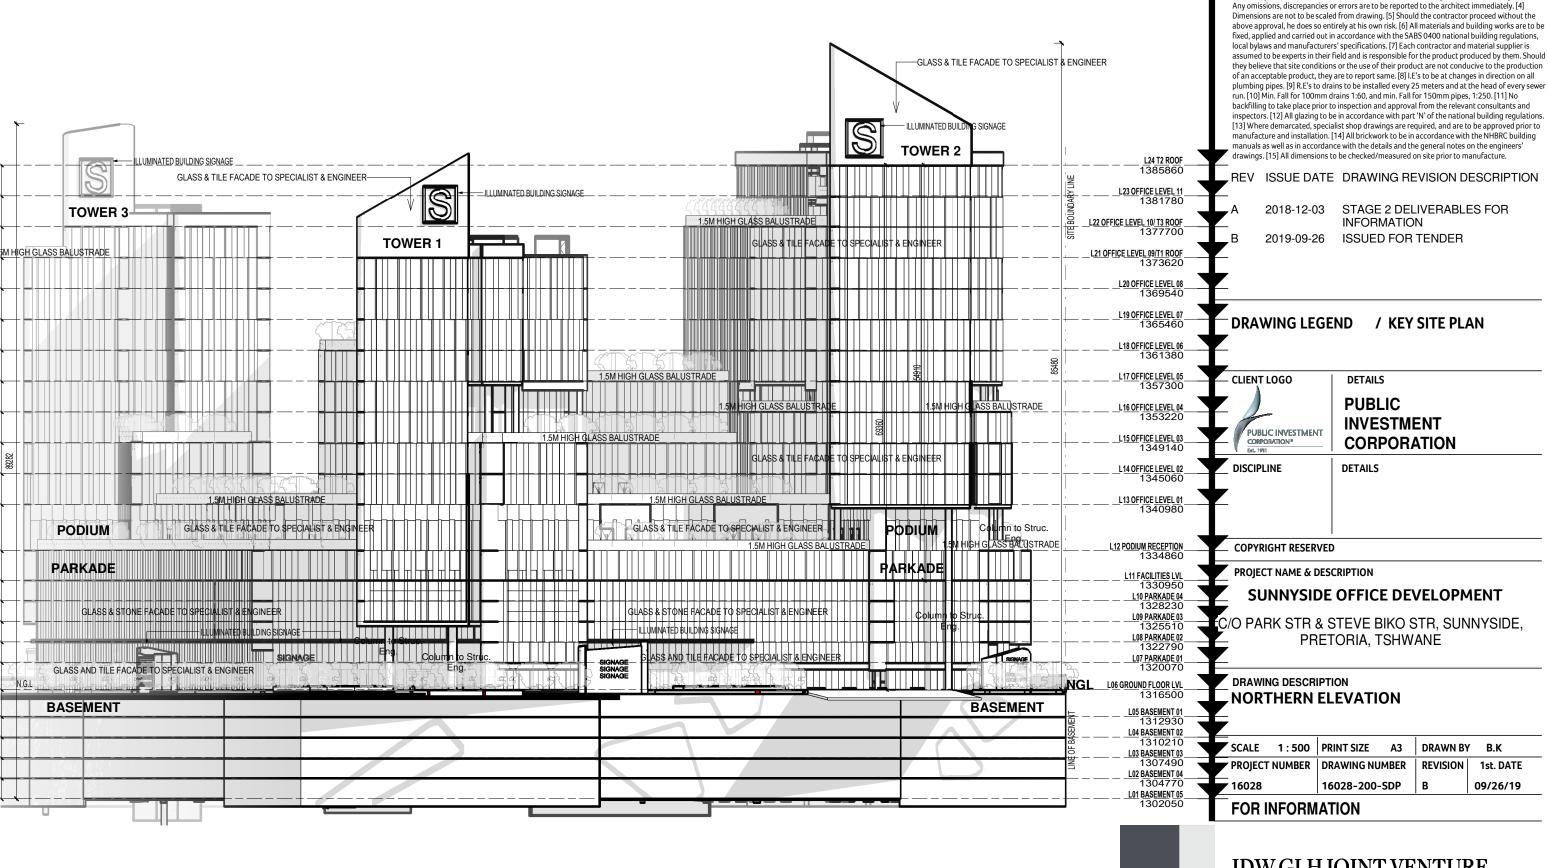
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PRETORIA Office 1, 267b, West Avenue, Centurion PHONE +27 (0) 12 663 1918



#### **NORTHERN ELEVATION**

**REFER TO ARTIST'S INTERPRETATION PERSPECTIVES FOR** FINISHES.

GLH IDW

### IDW GLH JOINT VENTURE

SAIA No. PG 0446

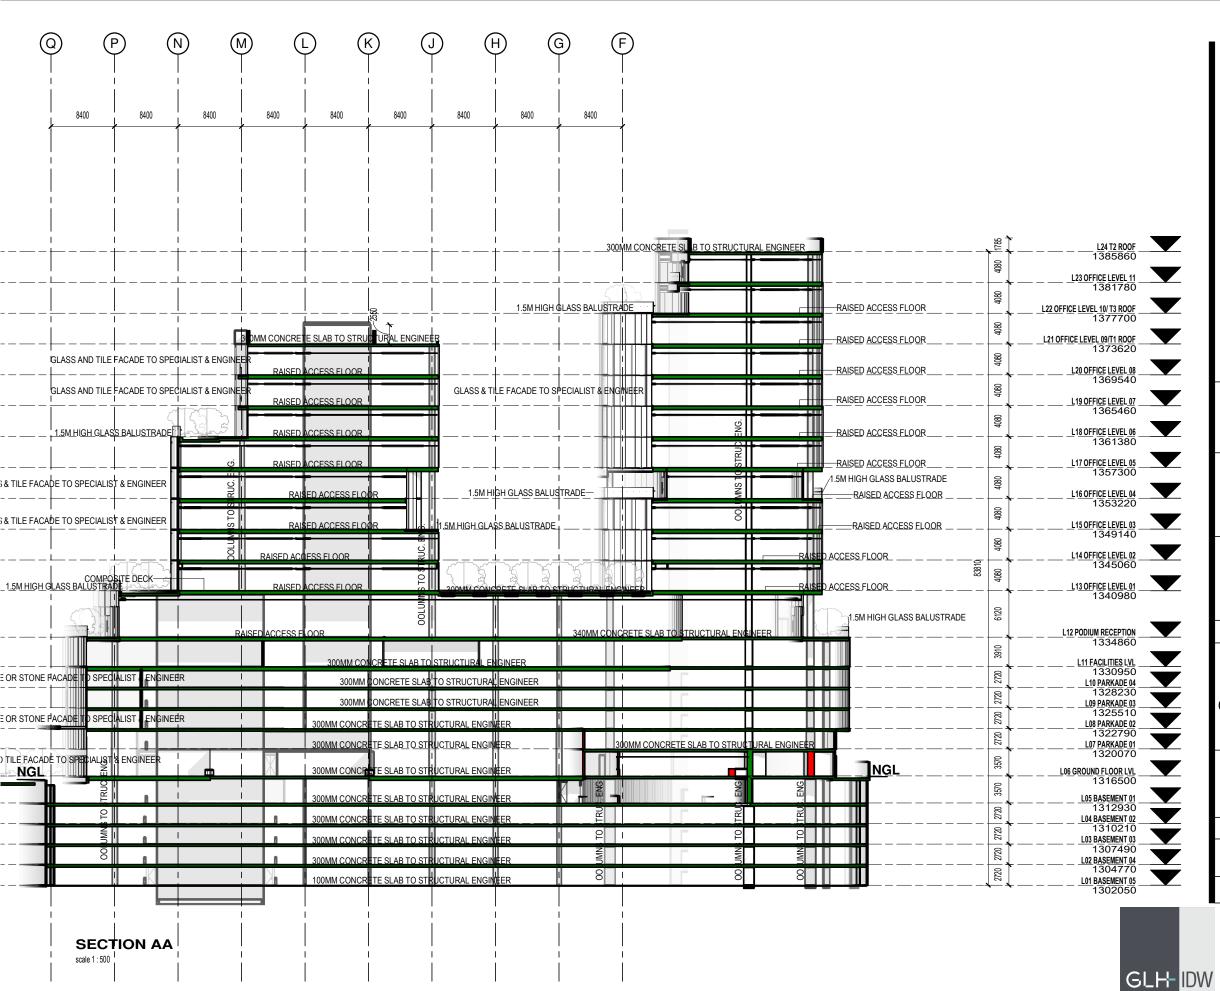
WEB www.glh.co.za

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REV ISSUE DATE DRAWING REVISION DESCRIPTION

2018-12-03 STAGE 2 DELIVERABLES FOR **INFORMATION** 

2019-09-26

ISSUED FOR TENDER

**DRAWING LEGEND** / KEY SITE PLAN

**CLIENT LOGO** 

**PUBLIC INVESTMENT** 

**PUBLIC** 

**INVESTMENT CORPORATION** 

DISCIPLINE

**DETAILS** 

**DETAILS** 

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#### SUNNYSIDE OFFICE DEVELOPMENT

C/O PARK STR & STEVE BIKO STR, SUNNYSIDE, PRETORIA, TSHWANE

**DRAWING DESCRIPTION SECTION AA** 

SCALE 1:500 PRINT SIZE A3 DRAWN BY B.K PROJECT NUMBER | DRAWING NUMBER REVISION 16028-300-SDP

FOR INFORMATION

### IDW GLH JOINT VENTURE

SAIA No. PG 0446

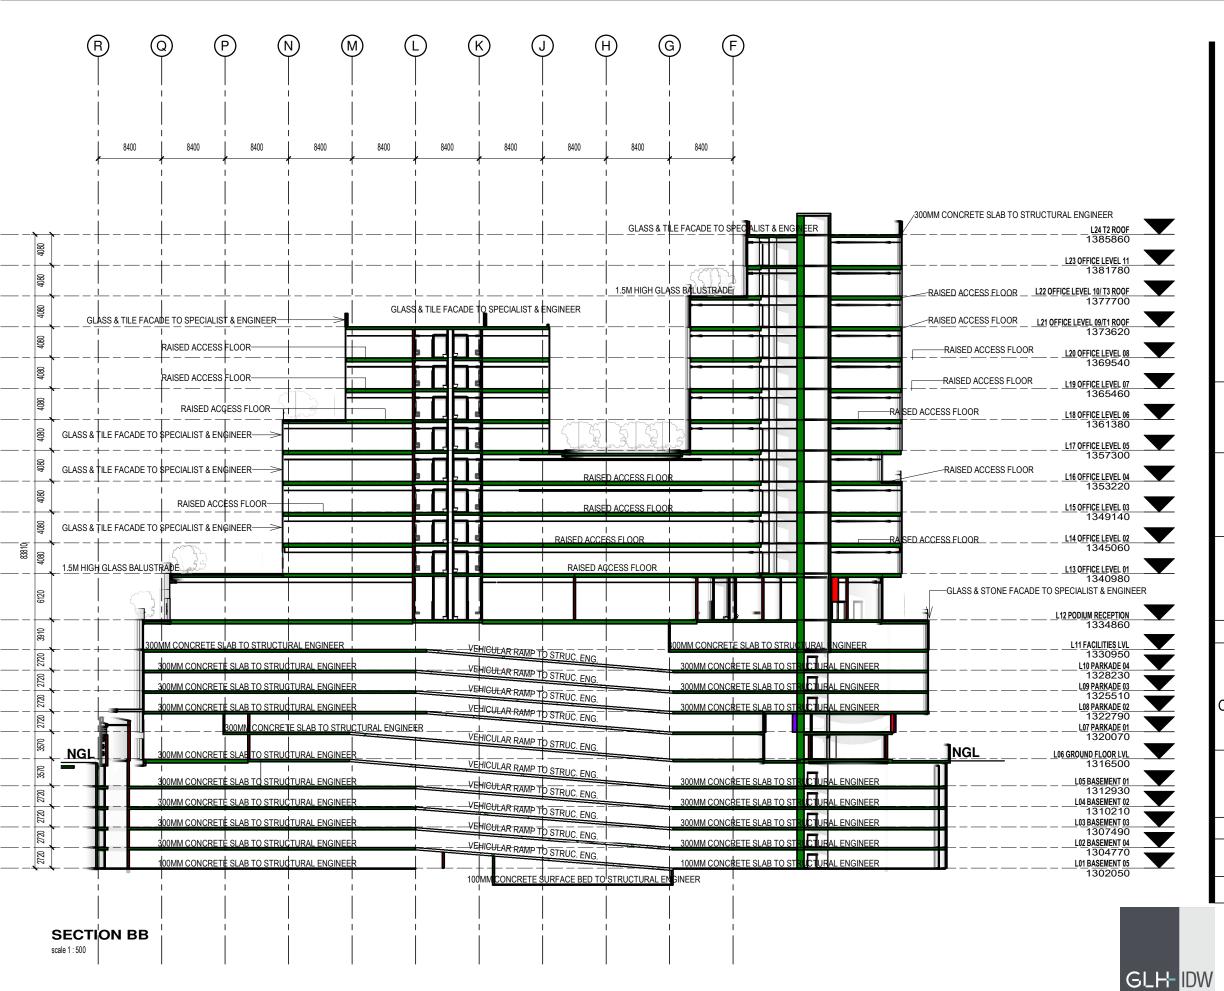
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1st. DATE

09/26/19



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REV ISSUE DATE DRAWING REVISION DESCRIPTION

2018-12-03 STAGE 2 DELIVERABLES FOR INFORMATION

B 2019-09-26 ISSUED FOR TENDER

DRAWING LEGEND / KEY SITE PLAN

CLIENT LOGO

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#### SUNNYSIDE OFFICE DEVELOPMENT

C/O PARK STR & STEVE BIKO STR, SUNNYSIDE, PRETORIA, TSHWANE

DRAWING DESCRIPTION SECTION BB

 SCALE
 1:500
 PRINT SIZE
 A3
 DRAWN BY
 B.K

 PROJECT NUMBER
 DRAWING NUMBER
 REVISION
 1st. DATE

 16028
 16028-301-SDP
 B
 09/26/19

FOR INFORMATION

### IDW GLH JOINT VENTURE

SAIA No. PG 0446

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